

AMERICAN CONSULTING ENGINEERS & SURVEYORS, INC.

CIVIL & ENVIRONMENTAL ENGINEERS

LAND SURVEYORS

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East Montpelier Recreation Field Project Summary

The following project includes installation and grading of two "Berms". One at the northerly end of the parking area and one at the southern end. The berms are to be constructed as configured on the plans to redirect water run-off into a culvert under the northern ingress and into the discharge of the culvert at the southern egress. The entrance and exit will be reconfigured to B-71 standards and to direct highway run-off to the ditches. The parking area will be raised by installing gravel to the depth specified to prohibit water from running down the drive and to promote shedding of water to the sides of the parking area.

The site will also require some ditch cleaning and removal of brush, trees and fence along the road to promote visibility and aesthetics. Some localized grading will be required along this area. Some larger trees specified by the owner will be retained.

The total engineers estimate inclusive of the above described project is \$30,000 - \$35,000.

A contractor's estimate of the above described project came in at \$30,000.

Robert Townsend PE, LS American Consulting Engineers and Surveyors

1. BEFORE ANY CLEARING OR GRUBBING BEGINS AND DURING ALL CONSTRUCTION STONE TRENCH BASINS SHALL BE CONSTRUCTED AT ALL WATER INLETS THAT WILL RECEIVE WATER FROM THE PROJECT.

2. ANY SOIL STOCKPLES WILL BE ENCIRCLED WITH SILT FENCE OR WITH THE GROUNDED STUMP SEDMENT FILTER.

4. EROSION CONTROL MEASURES SPECIFED ON THESE PLANS WILL BE REQUIRED FOR ALL NEW DITCHES, SWALES, ETC.

5. THE MINIMUM EROSION CONTROL MEASURES ARE SPECIFED AND THE ENGINEER MAY ADD MEASURES AS NEEDED AND THE CONTRACTOR MAY ALSO ADD MEASURES AS NEEDED. IT IS THE CONTRACTORS RESPONSIBILITY TO PREVENT EROSION FROM THE STE.

6. NEW GRASS LINED SWALES SHALL BE SEEDED AND MULCHED IMMEDIATELY UPON COMPLETION WITH THE SPECIFIED SEED MIXTURE D.

7. ON SLOPES 1 ON 2 TO 1 ON 3 NORTH AMERICAN GREEN 575 OR EQUAL EROSION BLANKET WILL BE PLACED AS SPECIFED BY THE MANUFACTURER.

B. ALL DISTURBED AREAS WILL BE SEEDED AND MULCHED WITHIN SEVEN DAYS OF CONSTRUCTION COMPLETION OF F MO WORK WILL BE DONE IN THE AREA FOR REATER THAN TWO WEDGS. THE PRAIL SEED MINUTURE IS D AS SPECIFIED.

9. ALL EROSION CONTROL MEASURES SHALL SE MAINTAINED THROUGHOUT THE PROJECT CONSTRUCTION AND UNTIL VEGETATION HAS BEEN ESTABLISHED IN ALL INSTRUMENT AREAS

SFEDING GUIDE
USING SEEDING MIXTURE 1 A - WELL DRAINED SOILS

SEED MIXTURE A POUND/ACRE

TALL FESCUE

CREEPING RED FESCUE 20

RED TOP


EROSION CONTROL NOTES (DISTURBED AREAS)

SILT FENCE SHALL BE INSTALLED SURROUNDING ALL DISTURBED AREAS ON THE DOWNSLOPE SIDE WHERE SLOPES ARE GREATE THAN 5% FOR MORE THAN 100°.


- 2. IF ANY EROSION BEGINS TO OCCUR, IMMEDIATE REMEDIAL MEASURES WILL BE TAKEN,
- IF EROSION CONTINUES CONTACT THE PROJECT ENGINEER.
- THE SITE CONTRACTOR IS RESPONSIBLE FOR THE SITE AT ALL TIMES UNTIL THE WORK IS DEEMED COMPLETE.

S) THE DISTURBED AREAS MUST BE

AND MUTCHED VZ 200H VZ BUT SHOULD SE NO LATER THAN 48 HOURS FOLLOWING COMPLETION OR FINISH GRADE

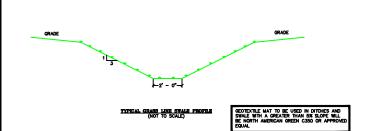

- ALL BLANKETS ARE TO BE INSTALLED PER THE MANUFACTURING SPECIFICATIONS. CONTACT ENGINEER OR MANUFACTURER FOR SPECIFICATIONS.
- IF NORTH AMERICAN GREEN BLANKETS ARE GOING TO BE USED, THE FOLLOWING IS THE APPROXIMATE PROCEDURE FOR THE INSTALLATION
- THE BLANKETS.
- A) PREPARE SOL BY APPLICATION OF LIME , FERTILIZER AND SEED.
 (PROCEDURE DEPRISE ON TYPE OF MATTING BERNG UTILIZED)
 B) BEGIN AT THE TOP OF THE SLOPE BY ANKYONION THE BLUNCT IN A
 TRENO LEEP & "WIDE TRENCH. BACK TILL AND COMPACT THE
 TRENO LEEP & "WIDE TRENCH. BACK TILL AND COMPACT THE
 WATER FLORING
 D) THE BLUNCTS DOWN THE HILL WITH THE DIRECTION OF THE
 WATER FLORING
 D) THE EDIES OF PARALLEL BLANKTS MUST BE STAPLED WITH
 APPROXIMATELY 2" OFFICIAP.

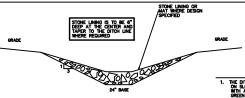


TYPICAL SWALE PROFILE (NOT TO SCALE)

THE DITCHES SHALL BE CONSTRUCTED AS SHOWN AND ON SLOPES GREATER THAN 5% WILL BE STONE LINED WITH AN EROSION PREVENTATIVE MAT (NORTH AMERICAN GREEN C-350 OR EQUAL) PLACED UNDER THE 6"- STONE.

- 2. THE FINISH SLOPES WILL NOT BE GREATER THAN 1 ON 3 SLOPES AND WILL BE SEEDED AND MULCHED IMMEDIATELY UPON COMPLETION WITH A STANDARD CONSERVATION MIX.
- THE MAXIMUM HEIGHT OF THE STONE LINING ON THE DITCH WILL BE THREE FEET (3") UP THE SLOPE.
- 4. THE SLOPE OF THE DITCH WILL DETERMINE THE TYPE OF MAT USED AS SPECIFIED ON THE PLANS BY THE ENGINEER.

THE MOST IMPORTANT PART OF INSTALLATION IS THE ANCHORING OF THE BLANKET INTO THE SOIL AT THE TOP OF THE SLOPE. DETAILS OF THE ANCHORING WILL BE PROVIDED UPON REQUEST.


GEOTEXTILE MAY TO BE USED IN DITCHES AND SWALE WITH A GREATER THAN 5% SLOPE WILL BE NORTH AMERICAN GREEN C305 OR APPROVED EQUAL, IN DITCHES LESS THAN 6% SLOPE THE MAT WILL BE SCISOBN BY NORTH AMERICAN GREEN

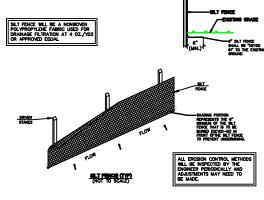


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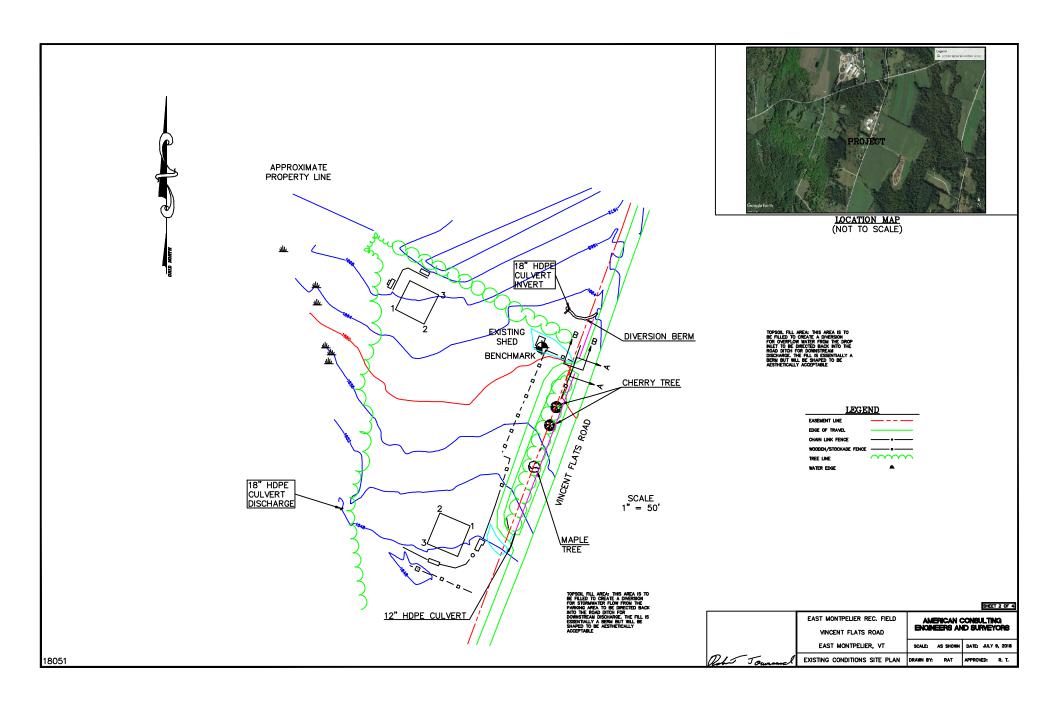
CHECK DAY NOTES 1. STONE CHECK DAMS WILL BE PLACED IN ALL DRAMAGE WAYS WITH A SLOPE OF SK OR CREATER.


- I. SPACING OF CHECK DAMS WILL BE SUCH THAT THE TOP OF THE LOWER DAM WILL BE THE BOTTOM OF THE UPPER DAM.
- 3. EXTEND STONE TO 18" BEYOND THE DITCH TO PREVENT CUTTING AROUND THE DAM.
- 5. ENSURE THAT CHANNEL APPURTENANCES SUCH AS CULVERT ENTRANCES BELOW CHECK DAMS ARE NOT SUBJECT TO DAMAGE OR BLOCKAGE FROM DISPLACED STONES.
- 6. ALL STONE CHECK DAMS WILL BECOME PART OF THE FINAL STONE LINED DITCHES.



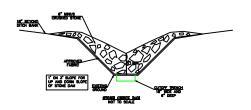


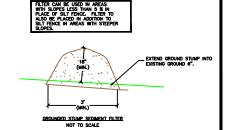
EAST MONTPELIER REC. FIELD AMERICAN CONSULTING ENGINEERS AND SURVEYORS VINCENT FLATS ROAD EAST MONTPELIER, VT SCALE: AS SHOWN DATE: OCT. 1, 2018 Det Tou EROSION CONTROL SHEET DRAWN BY: RT APPROVED: R. T.



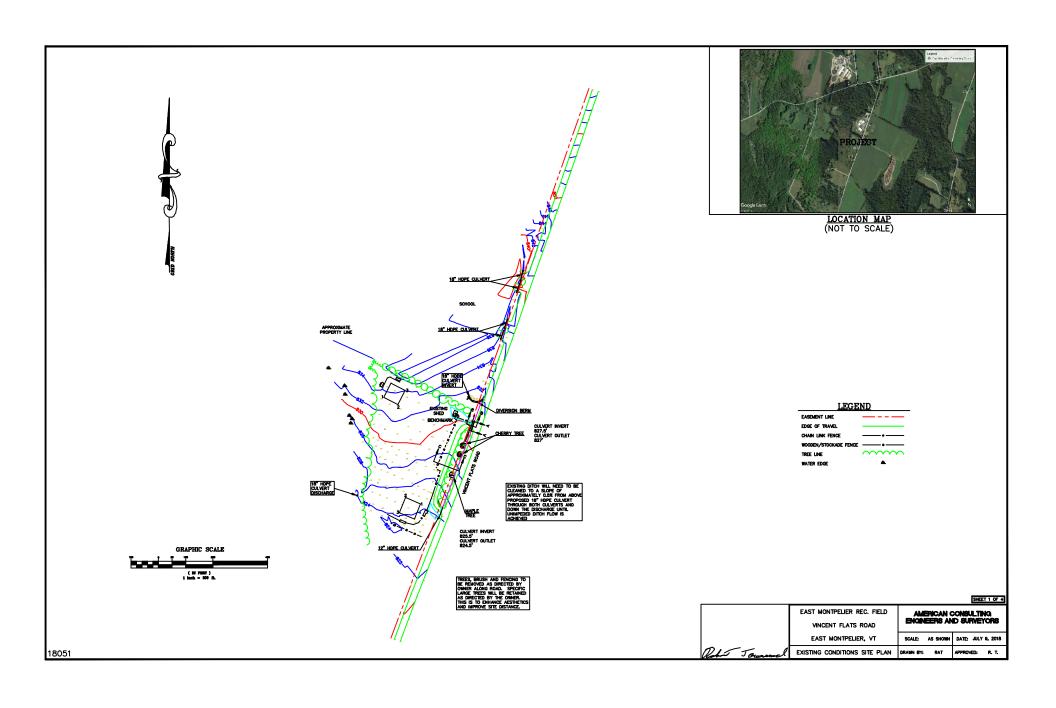




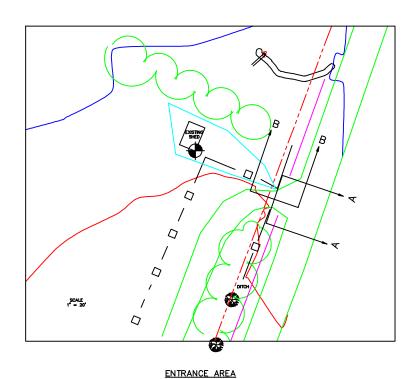

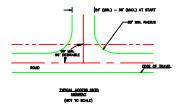



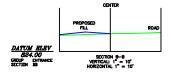

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	EAST MONTPELIER REC. FIELD	AMERICAN CONSULTING			
	VINCENT FLATS ROAD	ENGINEERS AND SURVEYORS			
	EAST MONTPELIER, VT	SCALE: AS SHOWN DATE: AUG. 31, 2018			
Och Towner	DETAIL SHEET	DRAWN BY: RAT APPROVED: R. T.			